




Suitability	Scale	Drawn	Client		
	1:1250 at A4	RR			
Drawing Status FOR APPROVAL		Date 27.09.24	Project	13 HASELFOOT LETCHWORTH GARDEN CITY	
Project No 0296	Drawing No RIC-XX-ZZ-DR-	A-0050	Title	SITE LOCATION PLAN	Revision P01

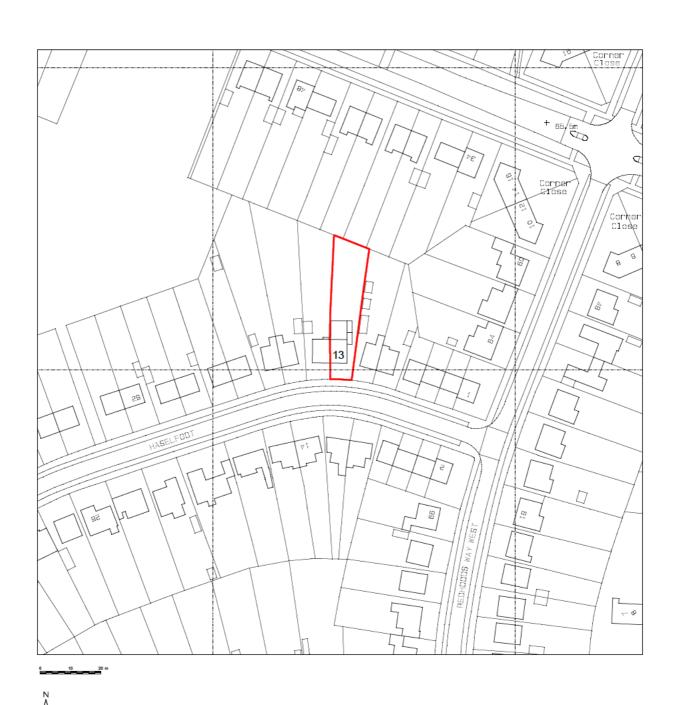


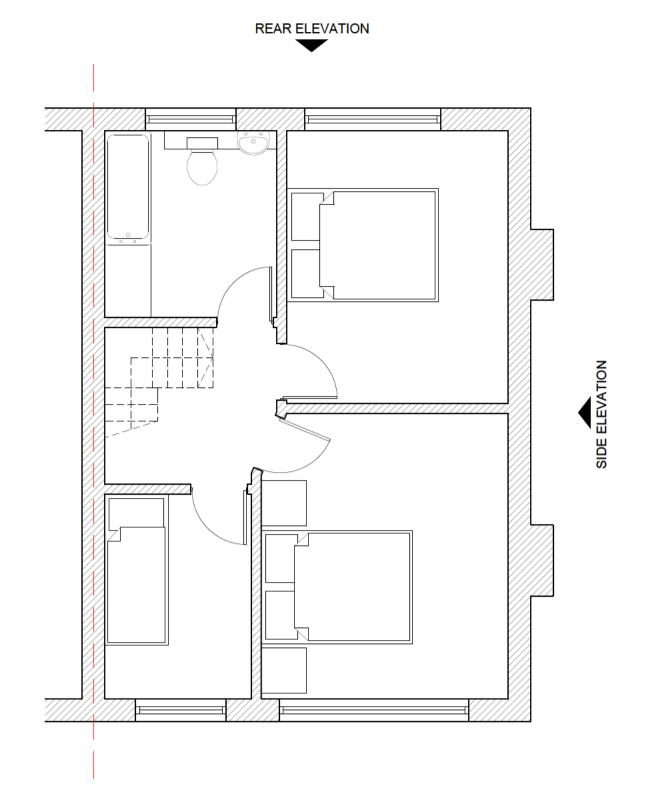

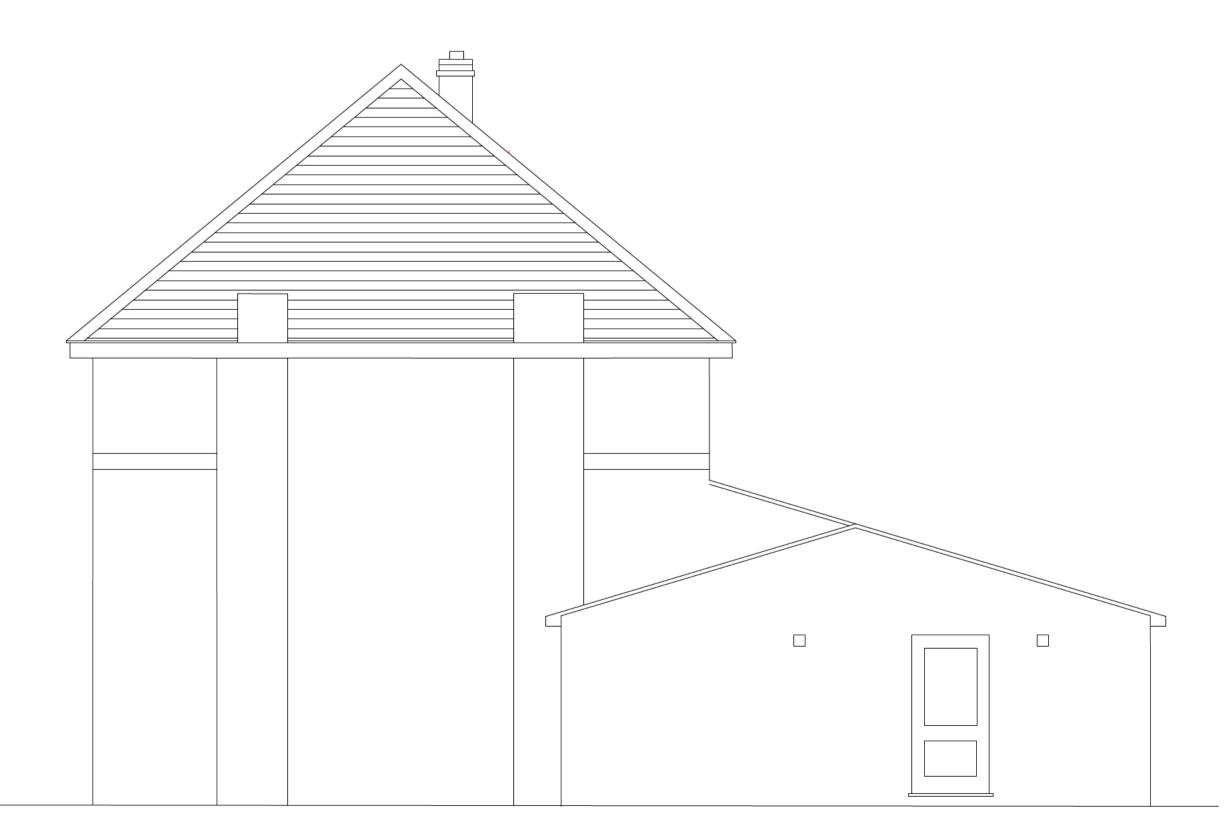






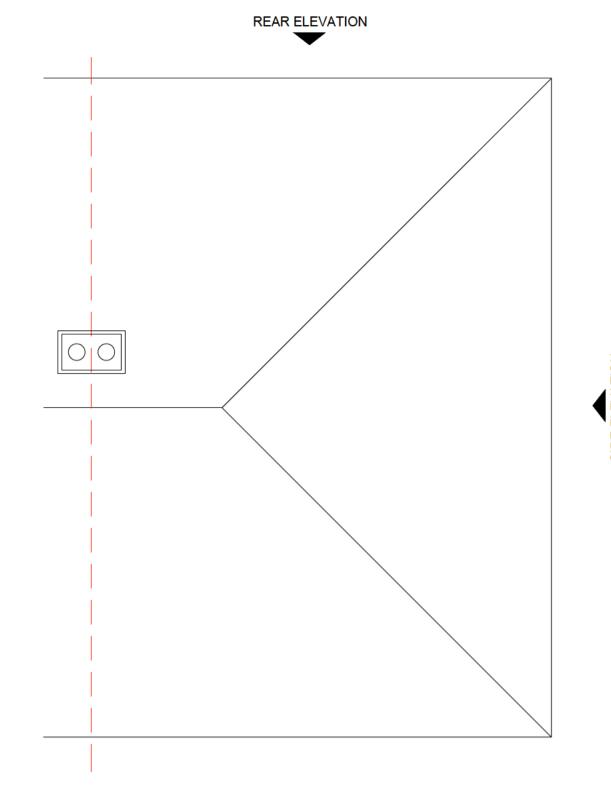

PROPOSED ROOF PLAN Scale: 1:50


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General notes

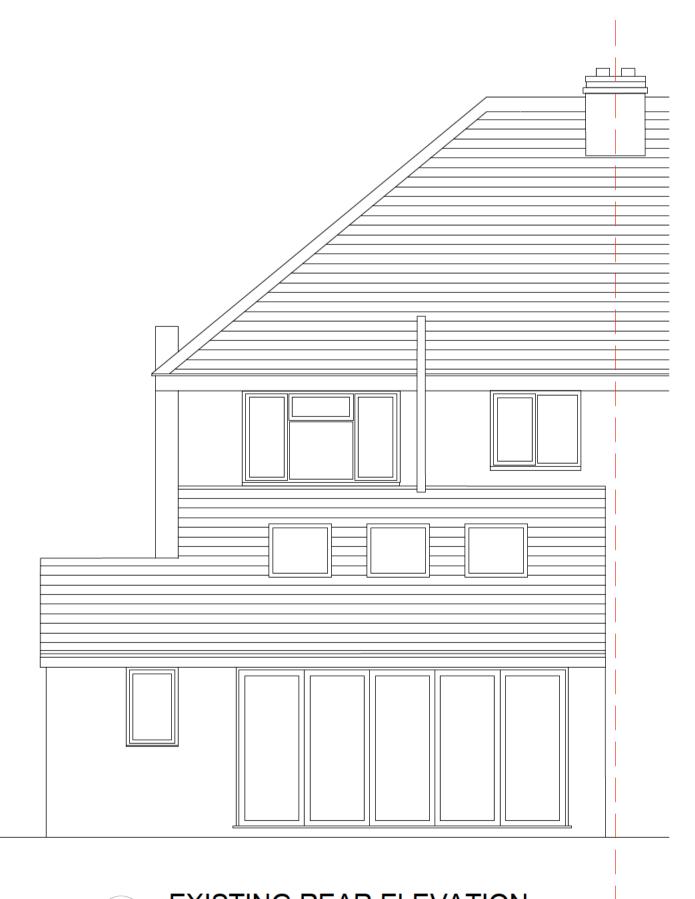- 1. These drawings have been prepared for the purpose of obtaining planning approval only.
- 2. All dimensions must be checked on site by the client and/or building
- 3. The client is responsible for all matters relating to Party Wall Act 1996.
- 4. Where existing drain runs are shown these are assumed only.
- The client is responsible for checking that boundaries are correct and proposals do not conflict with any restrictive covenants which may be in title deeds.
- 6. All works to be executed to the satisfaction of the Local Authority and to comply with all current Building Regulations, Planning Requirements, British Standards and Codes of Practice.

P01 27.09.24 ISSUED FOR APPROVAL 1:50 at A1 Drawing Status FOR APPROVAL 13 HASELFOOT LETCHWORTH GARDEN CITY GENERAL ARRANGEMENTS EXISTING PLANS AND ELEVATIONS RIC-XX-ZZ-DR-A-0100 P01




PROPOSED SIDE ELEVATION

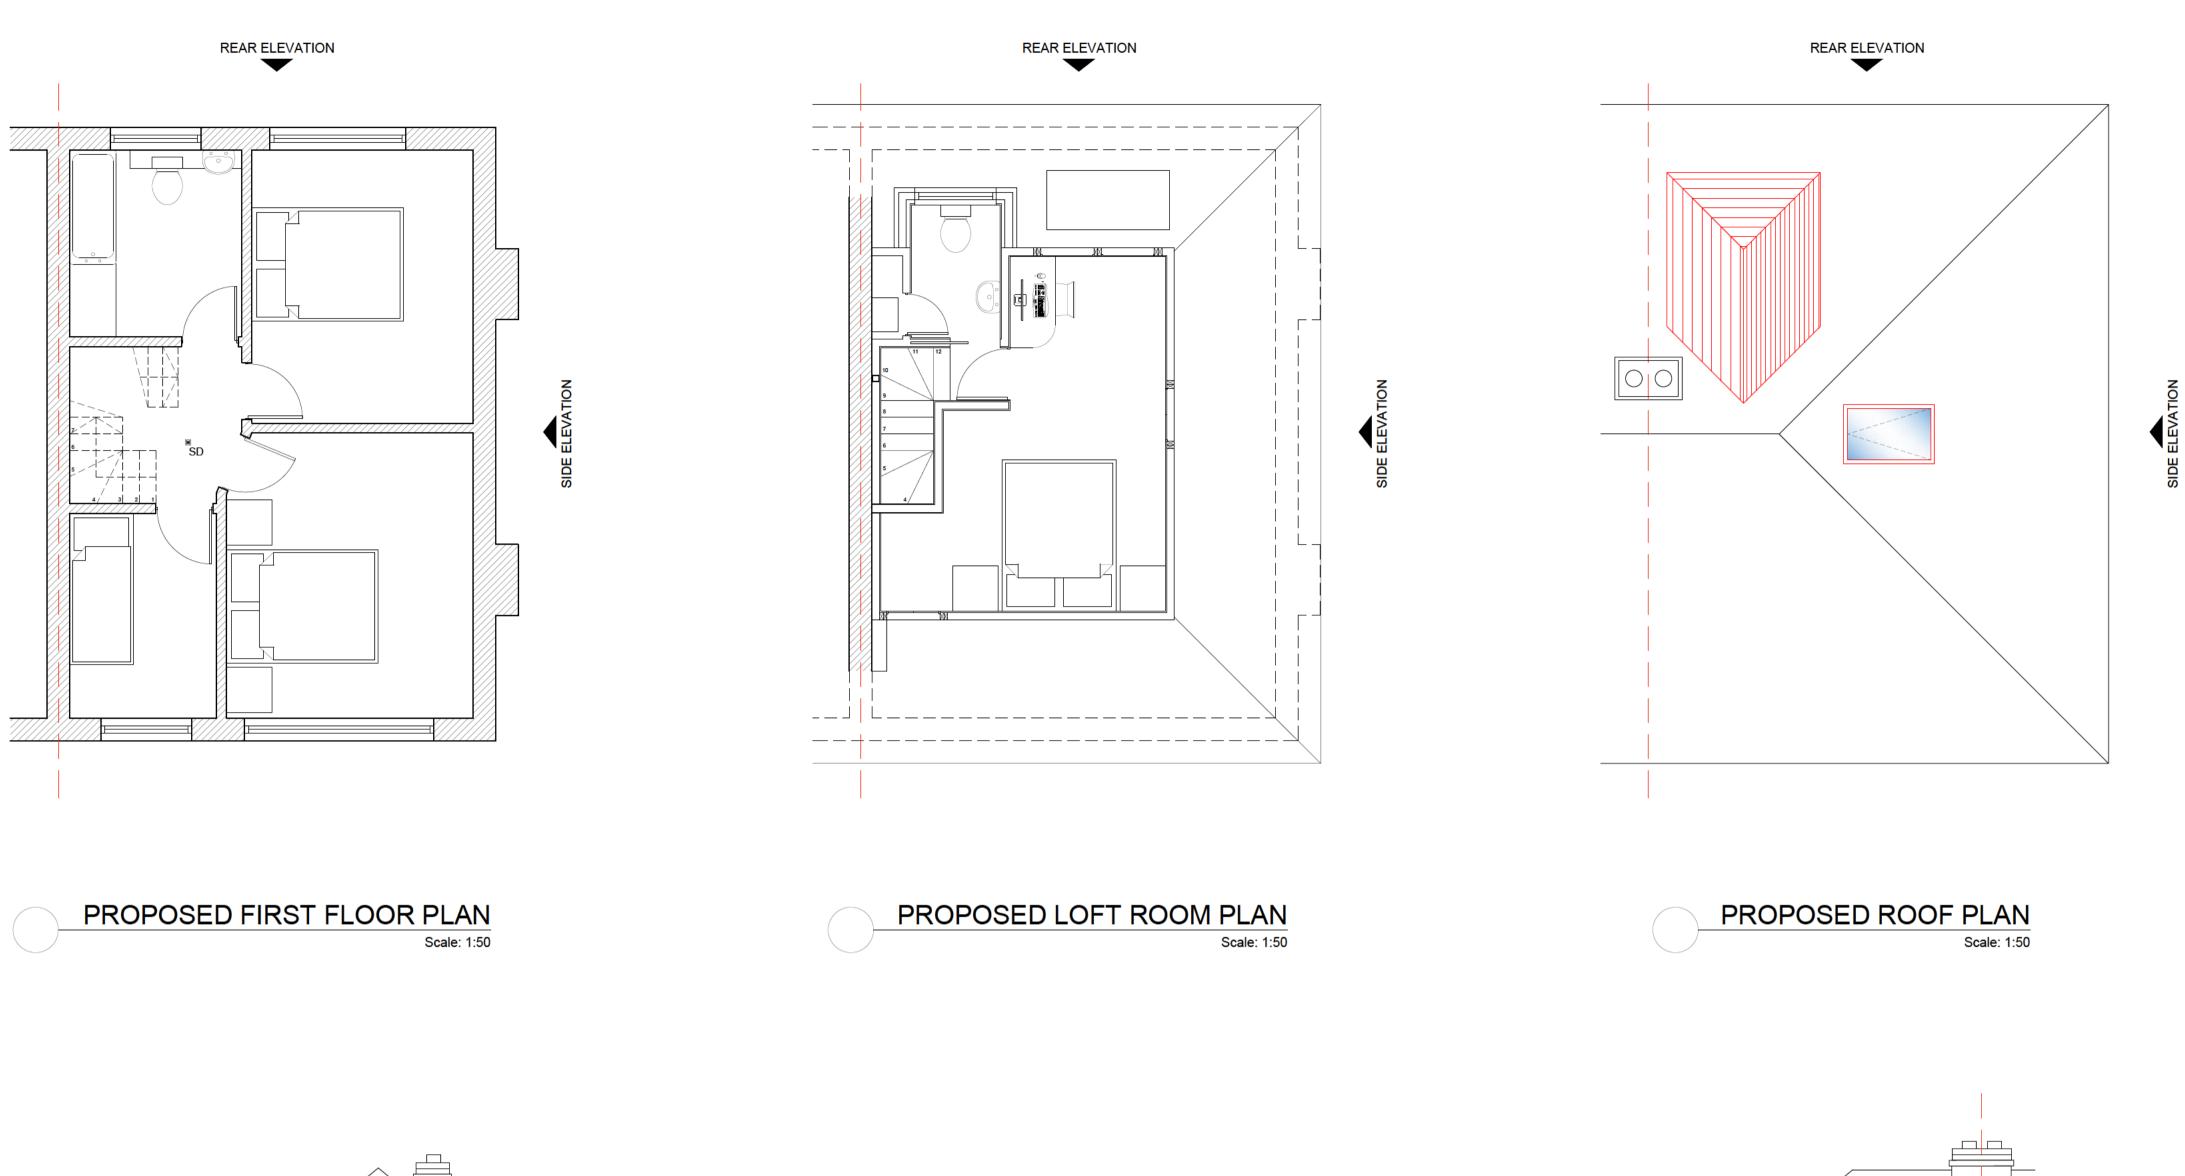Scale: 1:50





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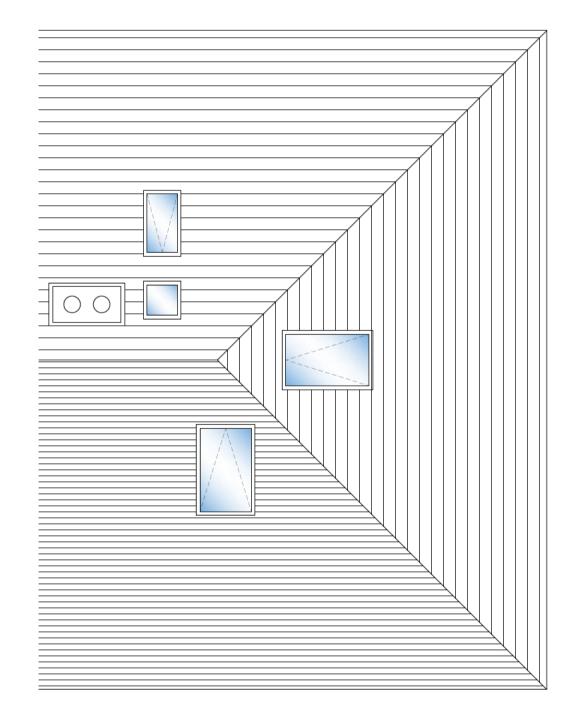


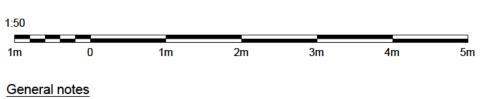- These drawings have been prepared for the purpose of obtaining planning approval only.
- All dimensions must be checked on site by the client and/or building contractor
- 3. The client is responsible for all matters relating to Party Wall Act 1996.
- 4. Where existing drain runs are shown these are assumed only.
- The client is responsible for checking that boundaries are correct and proposals do not conflict with any restrictive covenants which may be in title deeds.
- All works to be executed to the satisfaction of the Local Authority and to comply with all current Building Regulations, Planning Requirements, British Standards and Codes of Practice.

Min 2.0m headroom measured vertically above pitch line of stairs and e 900mm above the pitchline, handrail to be at least one side if stairs are s if they are wider. Ensure a clear width between handrails of minimum e unclimbable and should contain no space through which a 100mm sphere



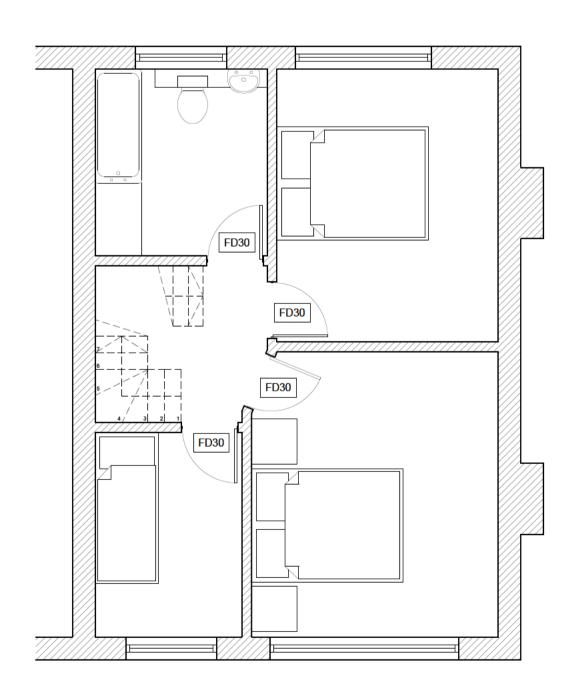

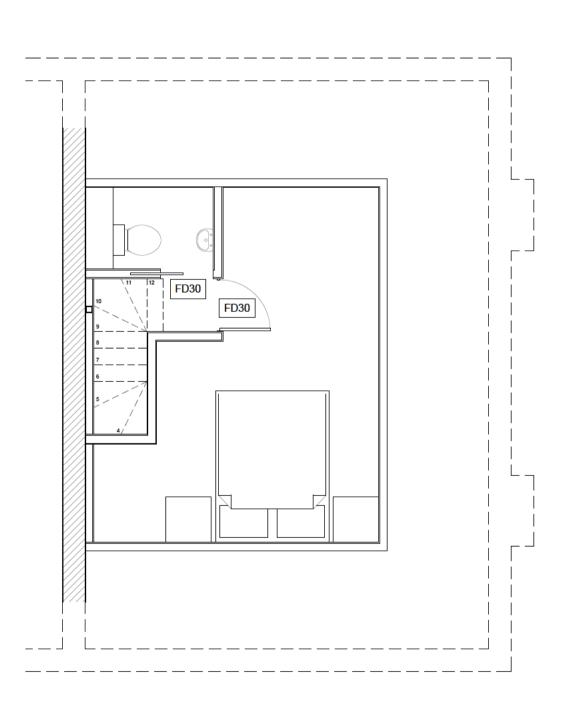


PROPOSED ROOF PLAN

NOT FOR CONSTRUCTION

P01 21.05.24 ISSUED FOR COMMENT

Revision Date

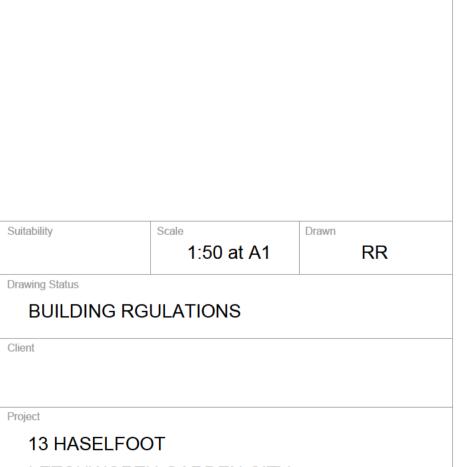


LETCHWORTH GARDEN CITY

BUILDING REGULATIONS PROPOSED LAYOUTS

Drawing No Revision P01 0296 BR01

PROPOSED FIRST FLOOR PLAN

PROPOSED LOFT ROOM PLAN

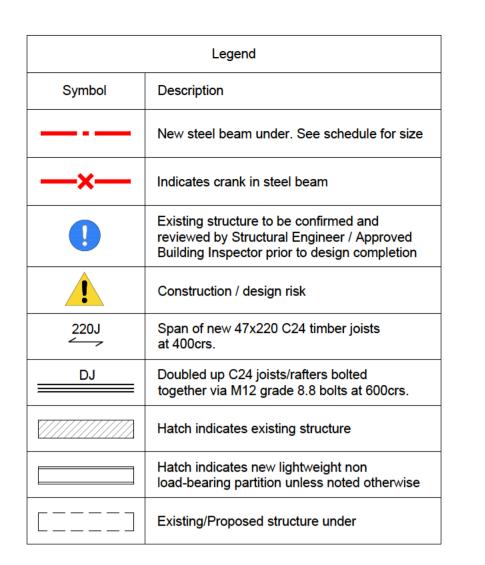

Steelwork


- All steelwork to be hot-rolled grade S355JR in accordance with BS EN 10025
- Hollow sections to be grade S355 (Celsius hot-finished by Tata).
- Steelwork to comply with National Structural Steelwork
 Specification (NSSS) for Building Construction 5th Edition CE Marking Version.
- All bolts to be min. M16 (grade 8.8) to BS 3692. Min. 4No. bolts per connection, unless noted otherwise.
- Steelwork shot blast cleaned to grade Sa2.5 and painted with two coats of High Build Zinc Phosphate Primer.
- Beam bearings built into solid external walls to be cased in concrete with 50mm cover all round.
- 7. Beams to bear fully on concrete spreaders.
- 8. All galvanized steel to be hot dipped to BS EN ISO 1461:2009 by a member of Galvanizers Association
- Steelwork Fabricator/Contractor to check all setting out prior to fabrication/procurement.
- All fabrication drawings to be based on accurate site dimensions.
- All simple connections to be designed and detailed by the fabricator.
- 12. Connection loads shown on plan thus:

Timber

- 1. Unless noted otherwise timbers to be grade C24.
- All timber to be preservative treated by organic solvent impregnation in accordance with the Wood Protection Association Commodity Specification to provide a service life of 50 years.
- 3. All fixings to be galvanised, sherardized or electro zinc plated
- 4. Joist hangers to manufacturers details to comply with BS 6178 Part 1, 1999
- 5. Lateral restraint (LRS) and holding down strap (HDS) positions as per NHBC flat/pitched roof requirements. Lateral restraint straps to be 30x5 galvanised steel, at max 2m centres, length across min 3No. perpendicular to joists/rafters (fixed at noggin positions) or 1200mm if parallel, with min 100mm bearing downturn. Holding down straps to be 30x2.5, min. 1m long at max. 2m centres
- 6. Joists to be doubled up under partitions in same direction as floor span and in bathrooms
- Floor joists to have two rows of solid noggins near supports (spans in excess of 2.5m to have an additional row at midspan and spans in excess of 4m to have an additional two rows at quarter span points).
- 8. Floor joists and rafters to be "regularised" in depth i.e to be tolerance T2 (BS EN 336).
- 9. All doubled up joists and trimmers bolted together with M12 grade 8.8 bolts at 900mm c/c unless noted otherwise.

General notes

- This drawing is to be read in conjunction with all other relevant Architect's, Engineer's, Mechanical and Electrical Engineers drawings together with the specifications.
- Design report RIC-XX-XX-RP-S-0001 is to be read in conjunction with this drawing series.
- All dimensions are in millimeters unless noted otherwise.
- Before commencing works the contractor is to ascertain the location of all existing services on and adjacent to the site, and allow for altering, maintaining and protecting where necessary during the works.
- The contractor shall check and confirm all dimensions prior to commencement of the works.
- 6. The contractor shall be responsible for providing all necessary temporary support to the building and any adjacent structures. The contractor is responsible for all temporary works design and a copy of such design shall be passed to the Structural Engineer for checking, prior to commencement.
- The contractor shall verify details of the existing structure and inform the engineer of any discrepancies prior to the procurement of the new structure.
- 8. Unless noted otherwise resin anchors comprise threaded studs (grade 8.8) with minimum embedment as below:
- 10mm dia. 90mm 12mm dia. - 125mm
- 16mm dia. 150mm
- 9. Anchors in brickwork set into RAWL R-KEM II for masonry10. Anchors in concrete set into RAWL R-KEM II for concrete

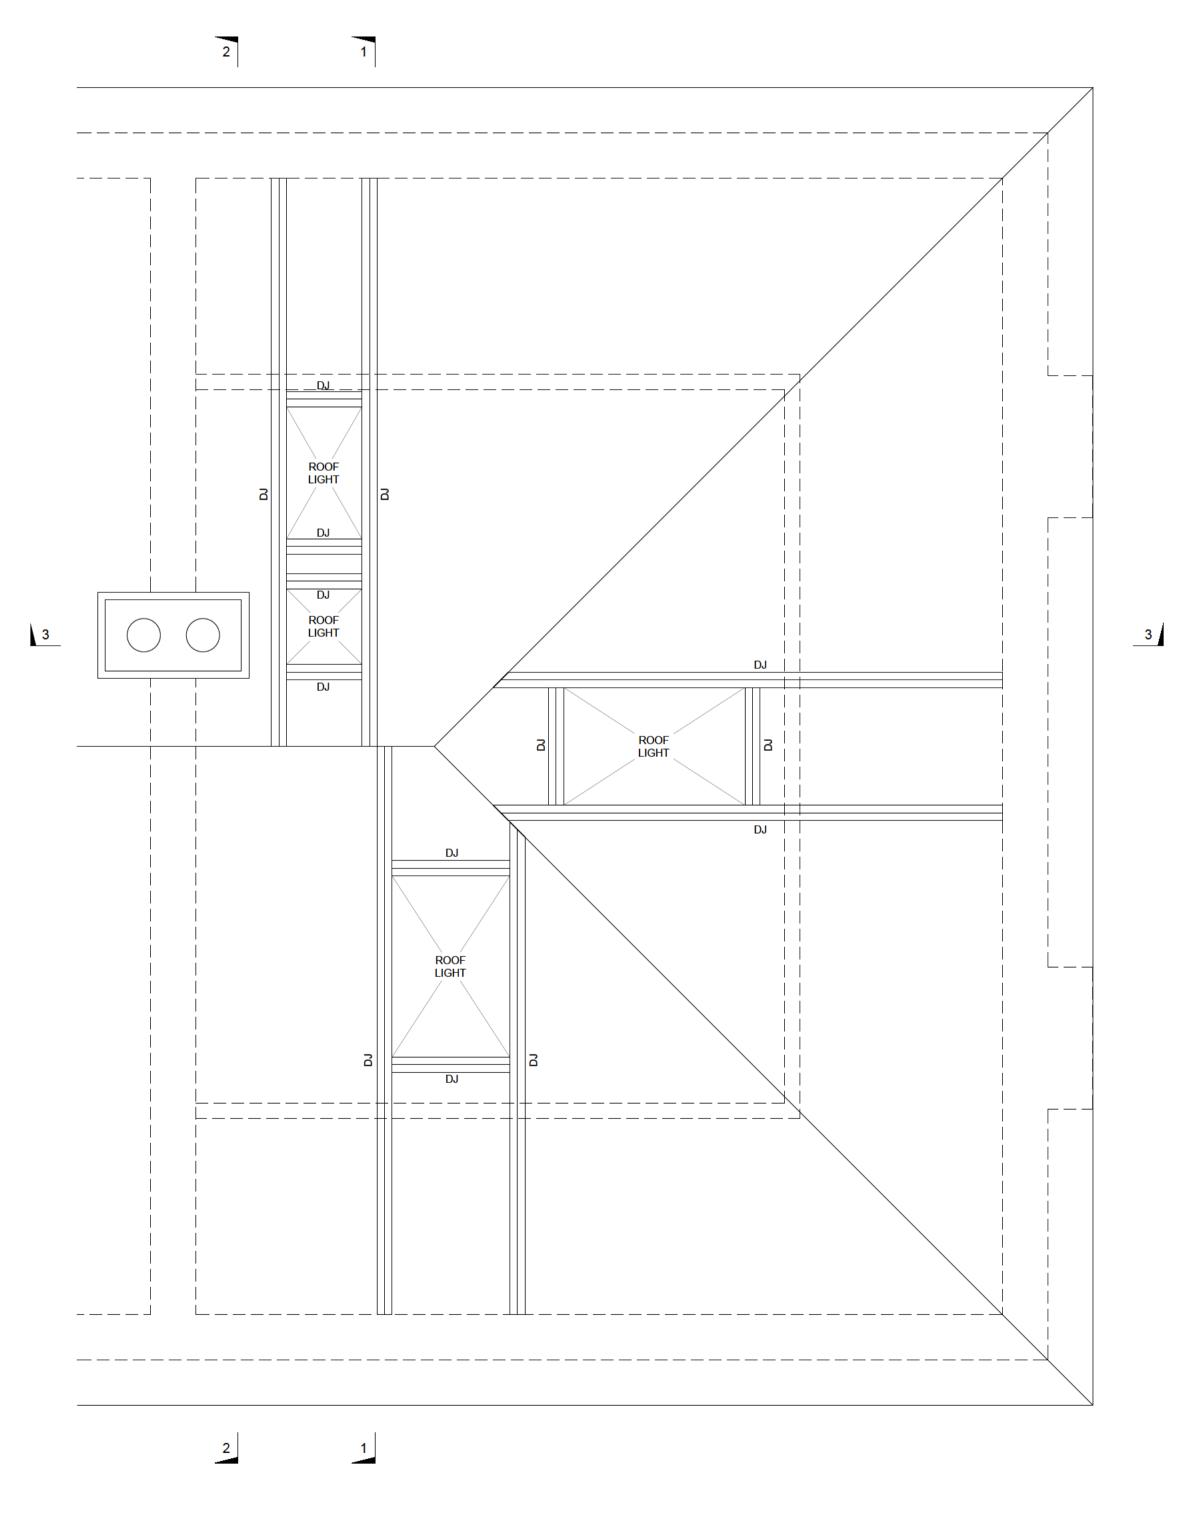

PS1 SBM PS2

PS2

PROPOSED STRUCTURAL LOFT PLAN

PROPOSED STRUCTURAL ROOF PLAN

Suitability

Scale

1:25 at A1

RR

Drawing Status

FOR COMMENT

Client

Project

13 HASELFOOT

LETCHWORTH GARDEN CITY

Title

BUILDING REGULATIONS

PROPOSED STRUCTURAL PLANS

Project No

0296


BR02

Revision

P01

19.03.24 ISSUED FOR COMMENT

	Electrical L	ayout Key	
Symbol	Description	Symbol	Description
+	Ceiling Pendant	D-	Single Socket
\oplus	Ceiling Mounted Spotlight	β-	Double Socket
⊕ ^{LE}	Low Energy Fitting	-a	Shaver Point
\boxtimes	Bathroom Light	⊳ _{TV}	Telephone Point
⊕	Ceiling Batten Lamp Holder	► _{BT}	Telephone Point
>	Wall Mounted Up-Lighter	► _{BT} TV	Sky / BT Point
(a)	Directional Spotlight		Data Point
Þ	Wall Mounted Spotlight	D	Single Socket Unswitched
—	Fluorescent Strip Light	•	Cooker Connection Unit
0	Passive Infra-Red External Light Fitting	Þ	Isolator Switch Extract Fan
•	Light Switch	>	Boiler Switch
~ 2	Light Switch - 2 Way	Þ	Fused Spur
⊛ _{SD}	Smoke Detector	MAS	Master Appliance Spur
⊛ _{HD}	Heat Detector	<u>D</u>	Burglar Alarm Dummy Box
⊞ CMD	Carbon Monoxide Detector	B	Burglar Alarm Bell Box
T	Thermostat	(DC)	Burglar Alarm Door Contact
□	Wall Extract Fan		Burglar Alarm PIR Detector
	Ceiling Mounted Extract Fan	Α	Alarm Keypad
\mathbb{H}	Ceiling Mounted Extract Fan with Light Fitting	AMP	Alarm Master Panel
••	Cooker / Hob Extract	CU	Consumer Unit
	Oven Switch	ELEC	Electric Meter
0	Bell Push	GAS	Gas Meter
□рв	Door Bell Sounder	€∰ CCTV	CCTV Camera
•	Radiator		

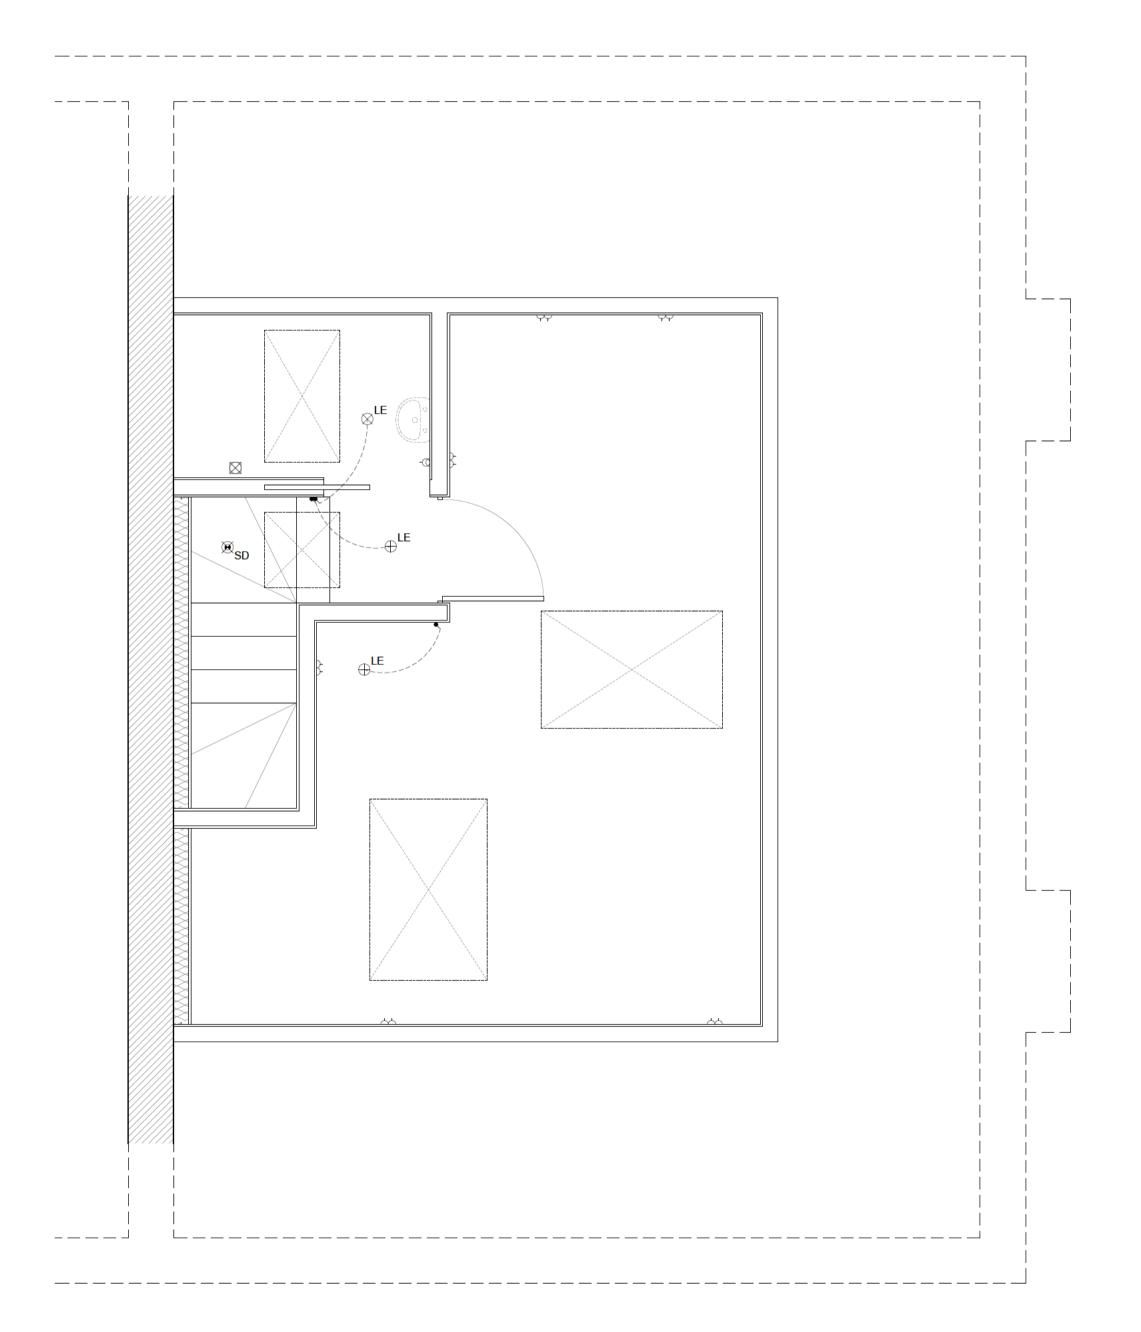

PROPOSED ELECTRICAL LAYOUT

ELECTRICAL


All electrical work required to meet the requirements of Part P (electrical safety) must be designed, installed, inspected and tested by a Competent Person registered under a Competent Person Self Certification Scheme such as BRE certification Ltd, BSI, NICEIC Certification Services or Zurich Ltd. An appropriate BS7671 Electrical Installation Certificate is to be issued for the work by a person competent to do so. A copy of a certificate will be given to Building Control on completion.


EXTRACT TO WC

WC to have mechanical ventilation ducted to external air with an extract rating of 15 l/s operated via the light switch. Vent to have a 15min overrun if no window in room. Internal doors should be provided with a 10mm gap below the door to aid air circulation. Ventilation provision in accordance with the Domestic Ventilation Compliance Guide. Intermittent extract fans to BS EN 13141-4. All fixed mechanical ventilation systems, where they can be tested and adjusted, shall be commissioned and a commissioning notice given to the Building Control Body.

INTERNAL LIGHTING

Install low energy light fittings that only take lamps having a luminous efficiency better than 80 lumens per circuit watt. All fixed to have lighting capacity (lm) 185 x total floor area, to comply with Part L of the current Building Regulations and the Domestic Building Services Compliance Guide.

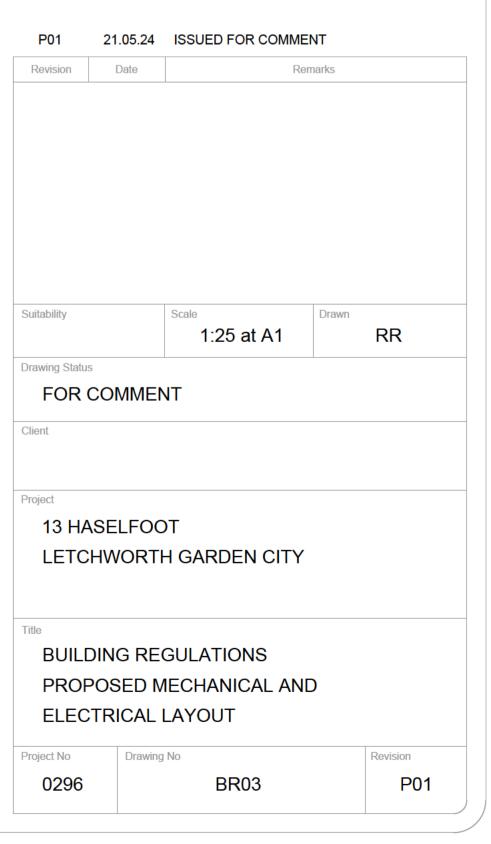


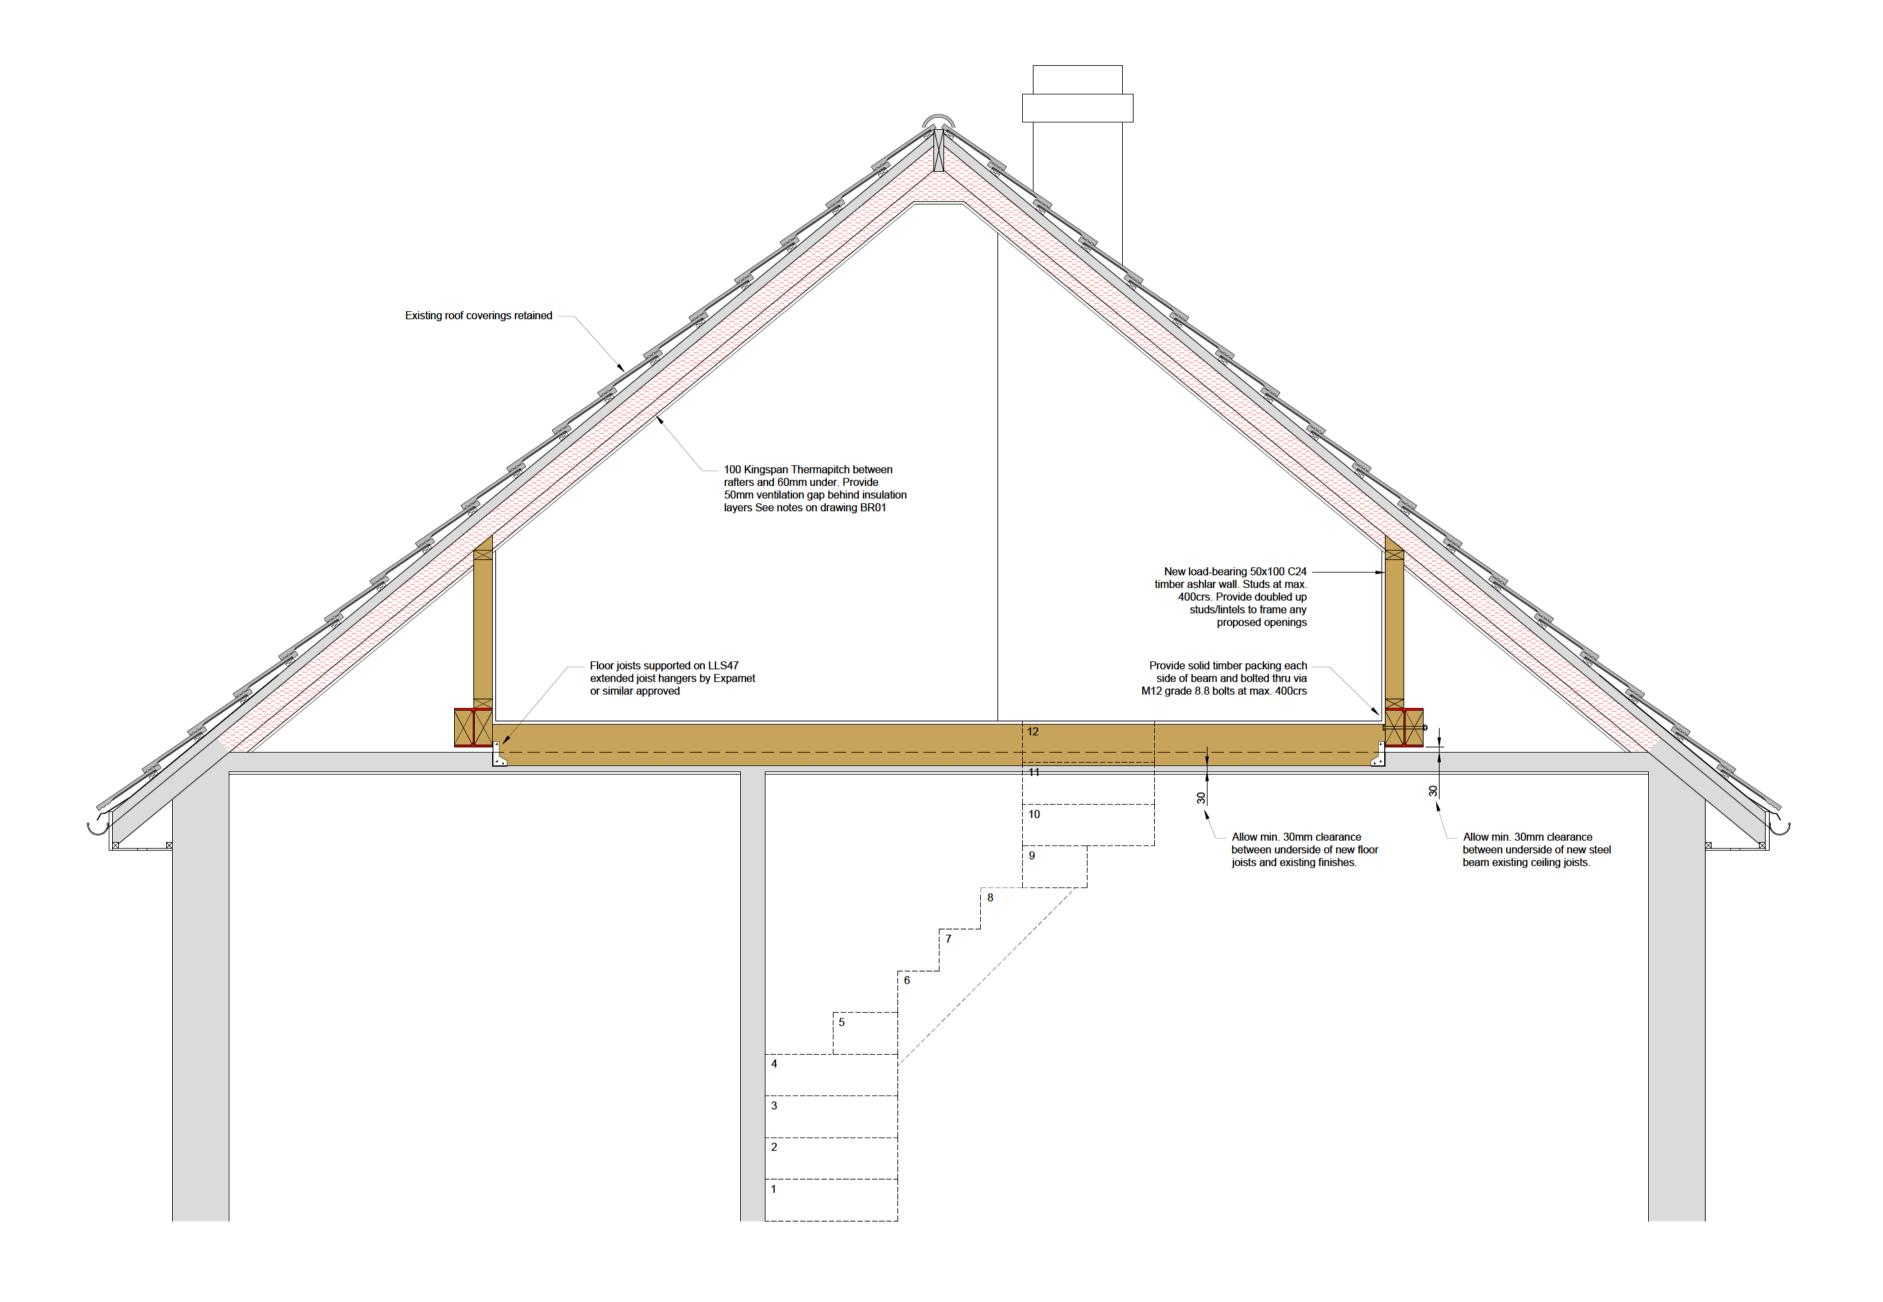

SECTION 1-1
Scale: 1:20

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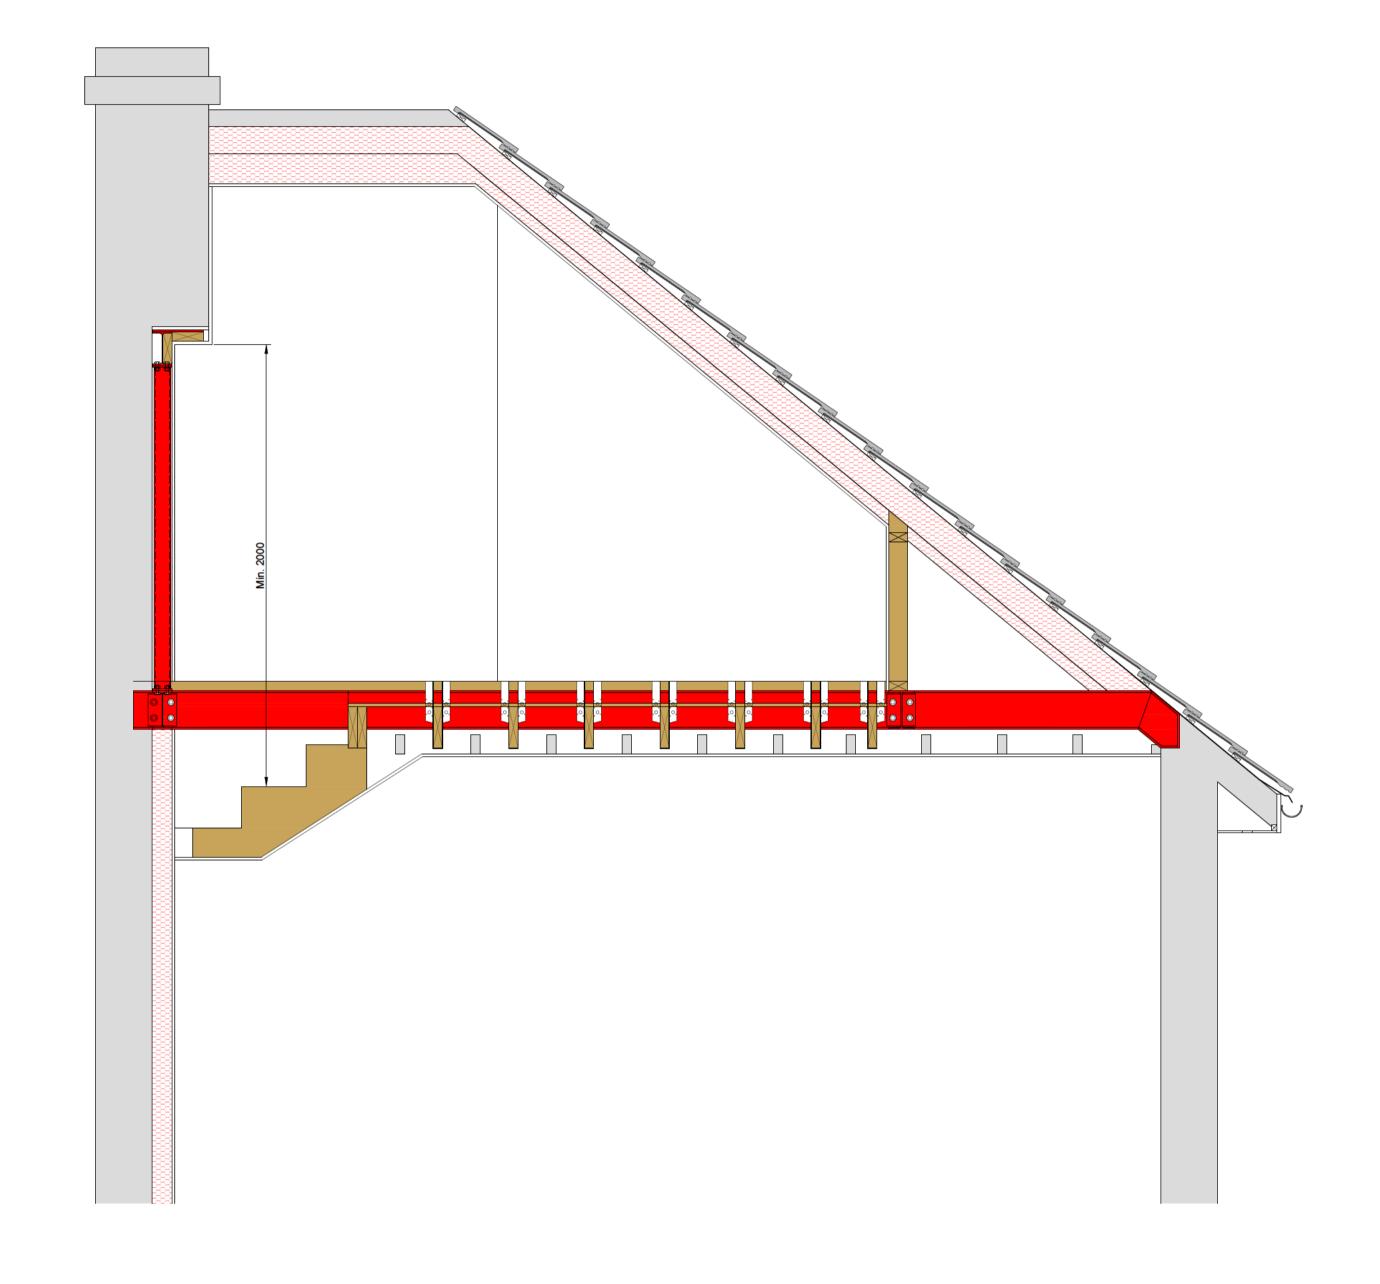
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0296		BR04	T01

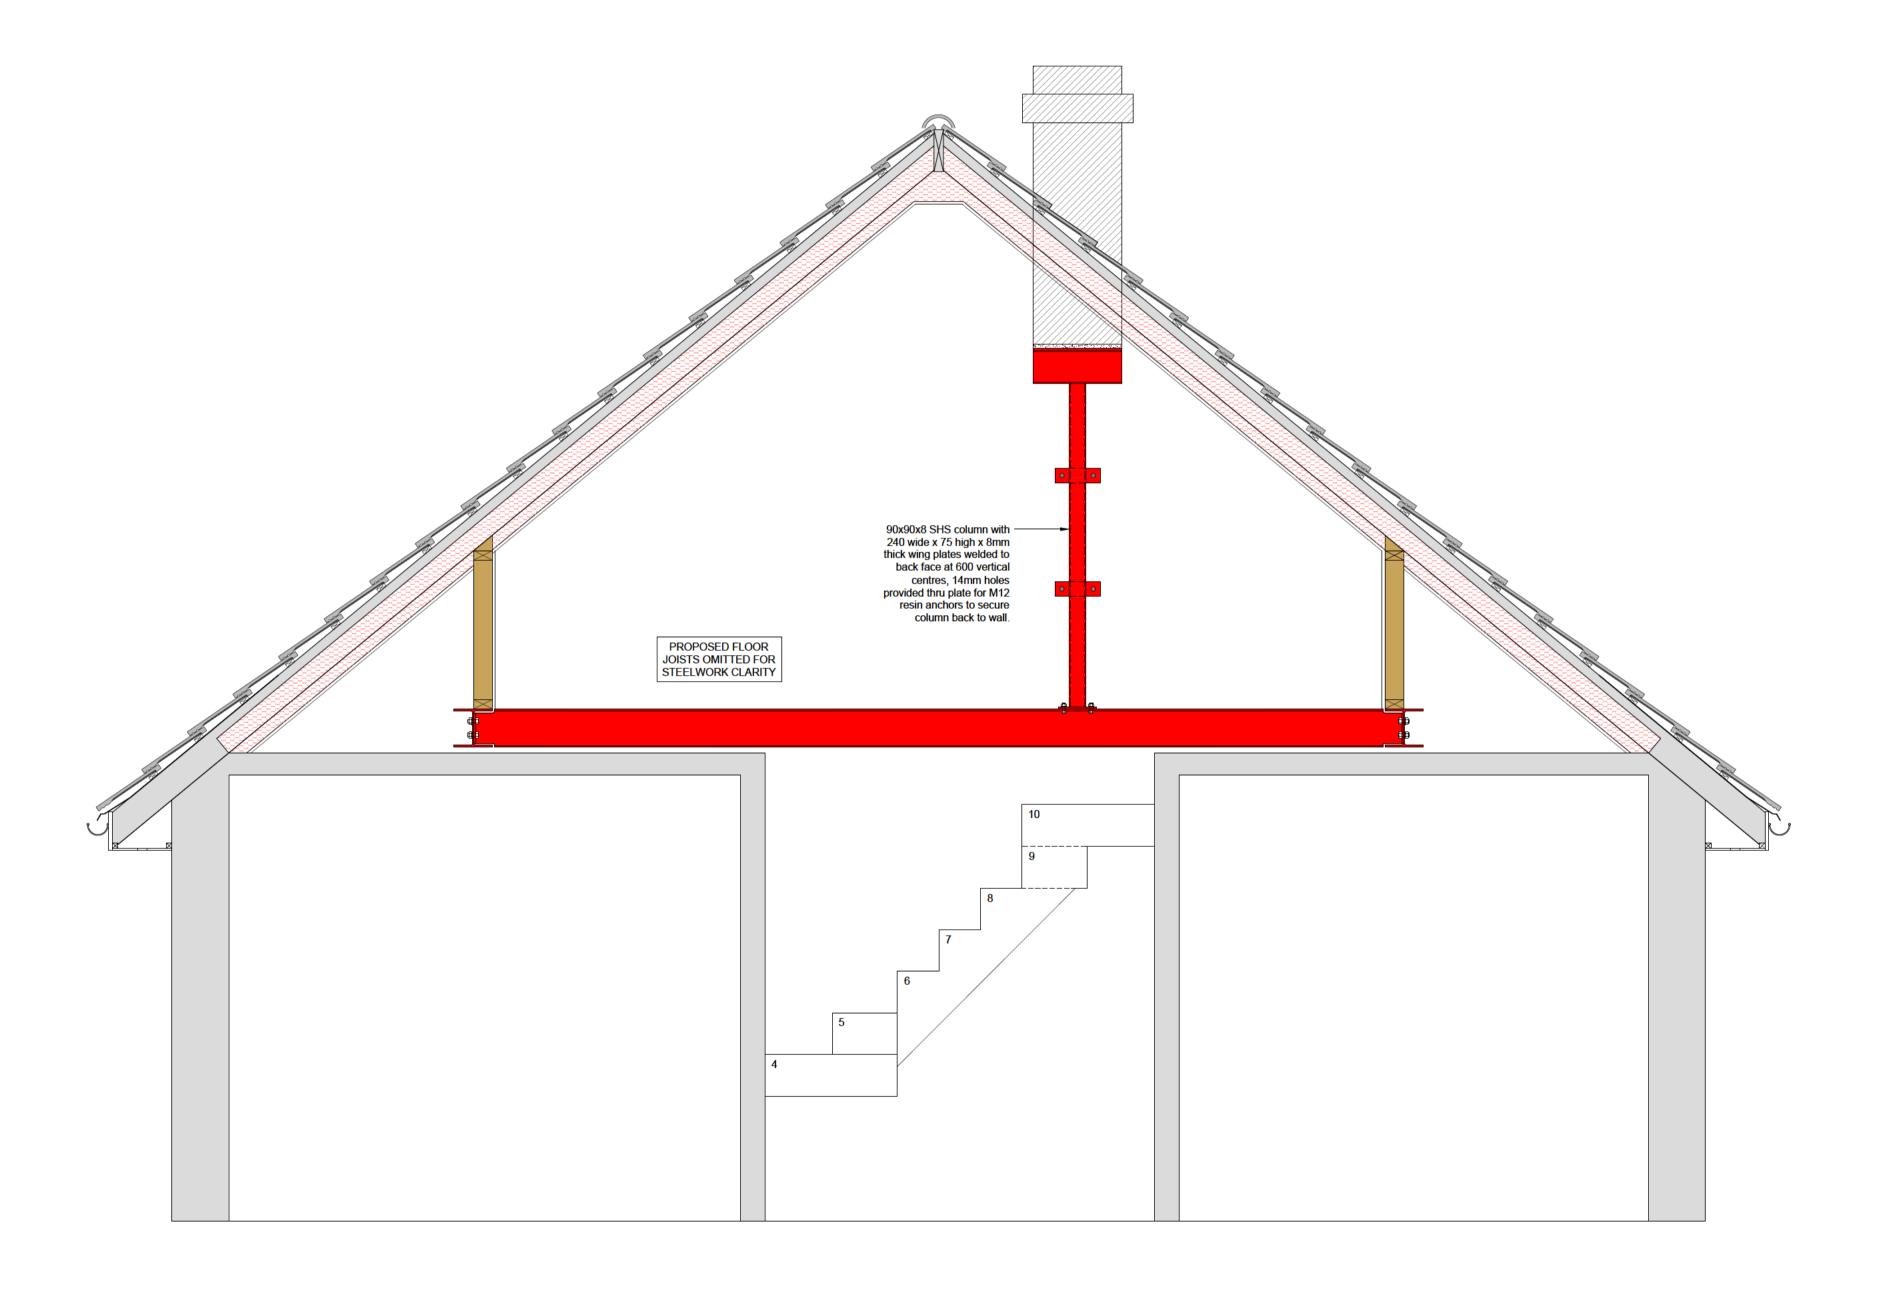

SECTION 2-2
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SECTION 3-3
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